GENERAL NOTES - PUBLIC WORKS

- 1. NO PERSON SHALL PERFORM ANY CONSTRUCTION ACTIVITY OR INSTALL ANY OBJECTS WITHIN THE PUBLIC RIGHTS-OF-WAY OR EASEMENTS OF THE CITY OF RIVERSIDE WITHOUT A VALID CONSTRUCTION PERMIT OR, A STREET OPENING PERMIT OR AN ENCROACHMENT PERMIT ISSUED BY THE CITY'S PUBLIC WORKS
- 2. IT SHALL BE THE RESPONSIBILITY OF THE CONTRACTOR TO CLEAR THE RIGHT-OF-WAY IN ACCORDANCE WITH THE PROVISIONS OF LAW AS IT AFFECTS EACH UTILITY INCLUDING IRRIGATION LINES AND APPURTENANCES AND AT NO COST TO THE CITY.
- 3. CONSTRUCTION SHALL BE IN ACCORDANCE WITH THE CITY OF RIVERSIDE DEPARTMENT OF PUBLIC WORKS STANDARD DRAWINGS, ITS SUPPLEMENTAL NOTES AND THE STANDARD SPECIFICATIONS FOR PUBLIC WORKS CONSTRUCTION, CURRENT EDITION.
- 4. THE PRIVATE ENGINEER SIGNING THESE PLANS IS RESPONSIBLE FOR ASSURING THE ACCURACY AND ACCEPTABILITY OF THE WORK HEREON. IN THE EVENT OF DISCREPANCIES ARISING DURING CONSTRUCTION, THE PRIVATE ENGINEER SHALL BE RESPONSIBLE FOR DETERMINING AN ACCEPTABLE SOLUTION AND REVISING THE PLANS FOR APPROVAL BY
- 5. QUANTITIES SHOWN ARE FOR INFORMATION ONLY AND THE CITY OF RIVERSIDE IS NOT RESPONSIBLE FOR THEIR ACCURACY.
- 6. THE DEVELOPER SHALL BE RESPONSIBLE FOR PRESERVING OR RE-ESTABLISHING AND REFERENCING SURVEY MONUMENTS DESTROYED, DISTURBED OR BURIED AS A RESULT OF CONSTRUCTION SHOWN HEREON.
- 7. ALL FLAGGED ELEVATIONS SHALL BE STAKED IN THE FIELD BY THE PRIVATE
- 8. THE CONTRACTOR SHALL CALL IN A LOCATION REQUEST TO UNDERGROUND SERVICE ALERT (USA). PHONE #1-800-227-2600, TWO WORKING DAYS BEFORE DIGGING. NO CONSTRUCTION PERMIT WILL BE ISSUED BY THE PUBLIC WORKS DEPARTMENT INVOLVING EXCAVATION FOR UNDERGROUND FACILITIES UNLESS THE APPLICANT HAS BEEN PROVIDED AN INQUIRY IDENTIFICATION NUMBER BY U.S.A.
- 9. CONTRACTOR IS TO VERIFY EXISTING SEWER ELEVATION PRIOR TO CONSTRUCTION.
- 10. LOCATION OF LATERALS TO BE DETERMINED IN THE FIELD AT THE DIRECTION OF THE OWNER. AVOID CONFLICT WITH PROPOSED AND/OR EXISTING FACILITIES.
- 11. NO FINISHED FLOOR ELEVATION SHALL BE LESS THAN 6" ABOVE THE UPPER MANHOLE RIM ELEVATION OF THE SEWER LINE SEGMENT BEING CONNECTED TO, WITHOUT HAVING A PROPER BACKWATER VALVE INSTALLED IN THE
- 12. A PLUG SHALL BE INSTALLED AND WILL REMAIN IN PLACE WHERE THE NEW SEWER CONNECTS WITH THE EXISTING SEWER UNTIL THE NEW SEWER IS ACCEPTED BY THE CITY.
- 13. THE SEWER CONTRACTOR SHALL ADJUST MANHOLES TO FINAL GRADE AFTER PAVING IS COMPLETED.
- 14. PIPE BEDDING SHALL BE CASE I PER CITY STD. DWG. NO. 452 UNLESS OTHERWISE SHOWN ON THE PLANS. IF GROUND WATER IS ENCOUNTERED. BEDDING SHALL BE CASE III IN ACCORDANCE WITH NOTE 2, CITY STD. DWG. NO. 452

NOTICE TO CONTRACTOR

THE HORIZONTAL AND VERTICAL LOCATIONS OF ANY UNDERGROUND UTILITY PIPES OR STRUCTURES SHOWN ON THESE PLANS WERE OBTAINED BY A RESEARCH OF THE AVAILABLE RECORDS. TO THE BEST OF OUR KNOWLEDGE, THERE ARE NO EXISTING UTILITIES EXCEPT THOSE SHOWN ON THESE PLANS.

UTILITY LINES SHOWN AND ANY OTHER LINES NOT OF RECORD OR NOT SHOWN ON THESE PLANS SHALL BE VERIFIED BY THE CONTRACTOR PRIOR TO COMMENCEMENT OF CONSTRUCTION. THE CONTRACTOR IS REQUIRED TO TAKE DUE PRECAUTIONARY MEASURES TO PROTECT THE EXISTING FACILITIES WHETHER SHOWN ON THESE PLANS OR NOT. THE QUANTITY ESTIMATES SHOWN HEREON ARE FOR THE USE OF GOVERNING AGENCIES IN DETERMINING BOND AMOUNT AND/OR FEES AND ARE NOT TO BE USED FOR BID PURPOSES.

SEWER CONSTRUCTION NOTES & QUANTITY ESTIMATE

	ITEM	QUANTITY	UNIT
1	INSTALL 8" VCP SEWER MAIN	927	LF
2	CONSTRUCT 4' Ø SEWER MANHOLES PER CITY STD. 500	5	EA
3	INSTALL SEWER LATERAL PER CITY STD. 562	19	EA
4	INSTALL 4" SEWER CLEANOUT PER CITY STD. 560	25	EA
5	PROTECT EXISTING PIPE IN PLACE	-	_
6	RECONSTRUCT EXISTING M.H BOTTOM. MODIFY SIDE INLET FROM 6" TO 8" DIAMETER.	1	EA
7	ADJUST MANHOLE RIM TO GRADE	1	EA
8	REMOVE EXISTING 6" SEWER PIPE	310	LF
9	REMOVE EXISTING SEWER MANHOLE	1	EA
10	CONNECT SEWER LATERAL WITH 13" X8" X4" 45" WYE	4	EΑ

REVIEWED BY: WESTERN MUNICIPAL WATER DISTRICT for Non-Interference Compliance SHEET 1 THROUGH 3 A) Sum Civil Engineer RCE 46212


ASSURING THE ACCURACY AND ACCEPTABILITY OF THE DESIGN HEREON. IN THE EVENT OF DISCREPANCIES ARISING AFTER CITY

APPROVAL OR DURING CONSTRUCTION. THE PRIVATE ENGINEER SHALL BE RESPONSIBLE FOR DETERMINING AN ACCEPTABLE SOLUTION AND REVISING THE PLANS FOR APPROVAL BY THE CITY.

WORK CONTAINED WITHIN THESE PLANS SHALL NOT GRADING PERMIT HAS BEEN ISSUED.

BENCHMARK.

POINT ID: 600-43-68 ELEV: 1532.700 DATUM: 1929 ADJ.: 1971 A STANDARD U.S.C. & G.S. BRASS DISK STAMPED "Z 1143 1961" IN A CONCRETE POST PROJECTING 0.4 FEET ABOVE GROUND, 0.35 MILES SOUTHEAST ALONG THE A.T.S.F. RAIL ROAD FROM VAN BUREN BLVD, 15 FEET SOUTHEAST OF MILEPOST 11, 183 FEET SOUTHEAST OF A SWITCH STAND, 70 FEET SOUTHWEST OF THE CENTERLINE OF THE SOUTHWEST LANES OF HWY 395. 23 FEET NORTHEAST OF THE NORTHEAST RAIL, 4 FEET SOUTH OF A TELEPHONE POLE, 2 1/2 FEET NORTH OF A WITNESS POST, AND LEVEL WITH

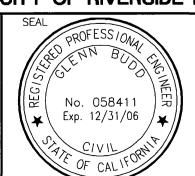

ABBREVIATIONS

ASPHALTIC CONCRETE

AGGREGATE BASE

CURB FACE

CENTERLINE

CONSTRUCTION

EDGE OF PAVEMENT

END CURVE

CONCRETE

EX, EXIST EXISTING

FLOW LINE

FINISH SURFACE

RIM ELEVATION

STORM DRAIN

STATION

SEWER MANHOLE

TOP OF CURB

TOP OF GRATE

WATER LINE

CROSSING

INVERT ELEVATION

The Keith Companies TKC 22690 Cactus Avenue, Suite 300 Moreno Valley, CA 92553-9024 (951) 697-8300 9/9/05

PROPOSED SEWER PIPE

EXISTING SEWER PIPE

CITY OF RIVERSIDE, CALIFORNIA PUBLIC WORKS DEPARTMENT


RVZ


DATE /0/3/05

SEWER IMPROVEMENT PLAN 215 RIVERSIDE. LLC PARCEL MAP NO. 32297

CITY OF RIVERSIDE, STATE OF CALIFORNIA

SEWER IMPROVEMENT PLAN PARCEL MAP NO.32297

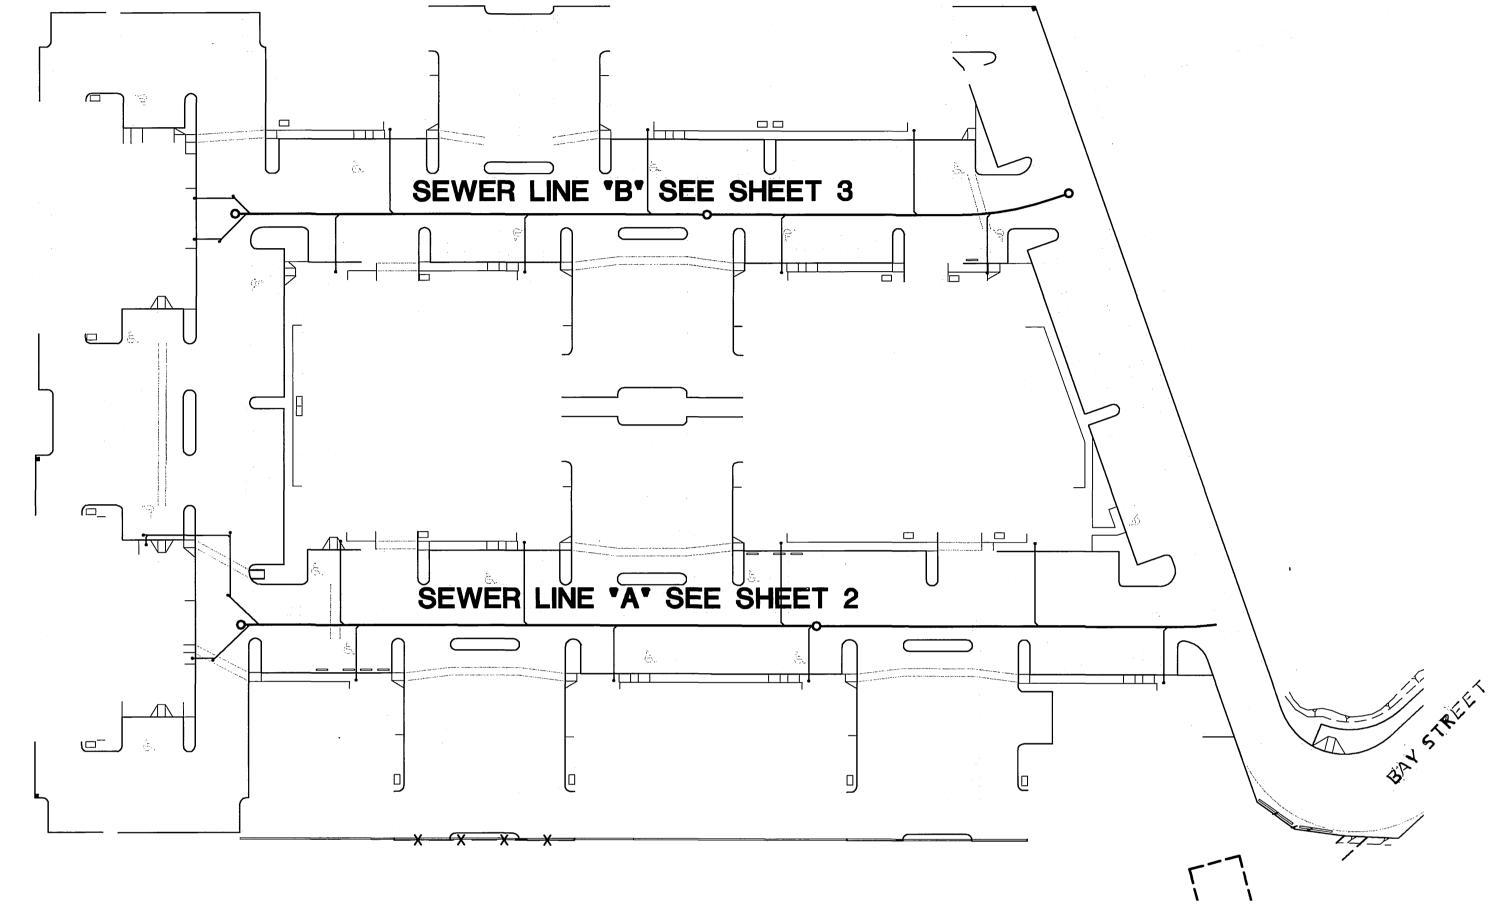

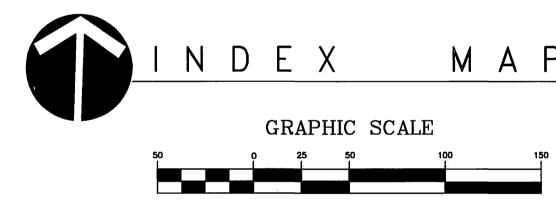

(IN FEET)

1 inch = 50 ft.LEGEND PROPOSED SEWER MANHOLE EXISTING SEWER MANHOLE PROPOSED SEWER PIPE EXISTING SEWER PIPE PROPOSED SEWER CLEANOUT CONSTRUCTION NOTE

_____ 8 W____

and the second of the second o

NOT TO SCALE

SOILS ENGINEER

VICINITY MAP

60 FRWY

Eucalyptus Avenue

Cottonwood Avenue

Alessandro Boulevard

Cactus Avenue

41715 ENTERPRISE CIRCLE N. ST. 103 TEMECULA, CA 92590-5661

LEIGHTON AND ASSOCIATES, INC.

APPLICANT/ OWNER 215 RIVERSIDE, LLC 110 W. EL PORTAL SAN CLEMENTE, CA 92672 PHONE 949-429-7720 FAX 949-429-7723

SOURCE OF TOPOGRAPHY

THE KEITH COMPANIES 22690 CACTUS AVENUE, SUITE 300 MORENO VALLEY, CA 92553-9024 PHONE 951-697-8300 FAX 951-653-5308

LEGAL DESCRIPTION:

ALL THAT PORTION OF THE SOUTHEAST QUARTER OF SECTION 10. TOWNSHIP 3 SOUTH, RANGE 4 WEST. SAN BERNARDINO BASE AND MERIDIAN, DESCRIBED AS FOLLOWS: COMMENCING AT A POINT ON THE WEST LINE OF SAID SOUTHEAST QUARTER WHICH BASIS SOUTH 00° 10' EAST 1,400.97 FEET FROM THE NORTHEAST CORNER OF SAID SOUTHEAST SOUTH QUARTER, SAID POINT BEING THE SOUTHWEST CORNER OF THAT CERTAIN PARCEL OF LAND CONVEYED TO MARY T. DEAN, A WIDOW BY DEED RECORDED NOVEMBER 6, 1947, IN BOOK 873, PAGE 369 OF OFFICIAL RECORDS; THENCE NORTH 89° 23' EAST, PARALLEL WHICH THE NORTH LINE OF SAID SOUTHEAST QUARTER A DISTANCE OF 350.00 FEET TO THE TRUE POINT OF BEGINNING OF THE PARCEL OF LAND TO BE DESCRIBED: THENCE CONTINUING NORTH 89° 23' EAST, PARALLEL WITH THE NORTH LINE OF SAID SOUTHEAST QUARTER DISTANCE OF 150.00 FEET: THENCE SOUTH 00° 10' EAST. PARALLEL WITH THE WEST LINE OF SAID SOUTHEAST LANE OF SAID SOUTHEAST QUARTER A DISTANCE OF 143.48 FEET; THENCE SOUTH 89° 23' WEST, PARALLEL WITH THE NORTH LINE OF SAID SOUTHEAST QUARTER A DISTANCE OF 154.00' FEET; THENCE NORTH 00° 10' WEST, PARALLEL WITH THE WEST LINE OF SAID SOUTHEAST QUARTER A DISTANCE OF 143.48 FEET TO THE TRUE POINT OF BEGINNING.

ASSESSORS PARCEL NO.

263-091-001 THRU 006 263-091-012, 013

SHEET INDEX

1.- TITLE SHEET 2.- SEWER LINE "A" PLAN AND PROFILE 3.- SEWER LINE "B" PLAN AND PROFILE

WDID # 833C333091

PW05-0016

TITLE SHEET HORIZ. SCALE: AS SHOWN VERT. SCALE: AS SHOWN

INDEXED 10-05-05

DIAL TOLL FREE LEAST TWO DAYS

BEFORE YOU DIG

UNDERGROUND SERVICE ALERT OF SOUTHERN CALIFORNIA

THE PRIVATE ENGINEER SIGNING THESE PLANS IS RESPONSIBLE FOR

COMMENCE UNTIL AN ENCROACHMENT PERMIT AND/OR A

CITY OF RIVERSIDE BUSINESS TAX CERTIFICATE #33595. EXPIRATION DATE 04/02/2006

STA.

